

Facility: The Cyril-Scott Company

FACILITY NAME AND LOCATION

The Cyril-Scott Company
Dept
3950 Lancaster - New Lexington Road
Lancaster, OH 43130 USA
Emergency 24-Hour Phone Number (716) 348-2036
County Fairfield
Fire District City of Lancaster, Ohio
Latitude 39 720905
Longitude -82 523537
MAILING ADDRESS

1-3

All facility information (not including chemical information) is identical to last year's submission

IDENTIFICATION NUMBERS:

Dun & Bradstreet 00-448-8300
NAICS 323111 (Commercial Printing (except Screen and Books))
RMP N/A

Is the facility manned? Manned Unmanned
Maximum No. of Occupants 200

REGULATORY INFORMATION

Subject to Emergency Planning under Section 302 of EPCRA (40 CFR part 355)? Yes No
Subject to Chem. Accident Prevention under Section 112(r) of CAA (40 CFR part 68, Risk Mgmt Pgm)? Yes No

STATE-SPECIFIC FACILITY DATA FIELDS FOR OH:

Confidential Location Forms Included
 Facility Name has changed
Previous facility name (if known):
 Owner / Operator has changed
Previous parent company/owner (if known)
 Initial Filing (First Time Filer)
 Updated Filing
 Annual Filing
Total EHS Chemicals Included 1
Number of Chemicals Included 4

CONTACT INFORMATION

City of Lancaster Fire Department,
Title
Contact Type(s) Fire Department
Address Lancaster, OH 43130 USA
Phones Emergency 911 Work (740) 687-6642
Email

Friesner, Paul (Chip)
Title Engineer & EHS
Contact Type(s): Fac Emergency Coordinator, Emergency Contact, Tier II Information Contact, Submitter
Address 6995 Ireland Road Lancaster, OH 43130 USA

June 15, 2020

Facility: The Cyril-Scott Company (continued)

Phones Work (740) 654-2112 Mobile - Cell: (740) 438-2497 24-hour (740) 438-2497
Email: chip.e.friesner@rrd.com

Gebhart, Jeffery

Title VP Operati
Contact Type(s): Owner / Operator, Emergency Contact
Address: 3950 Lancaster- New Lexington Road Lancaster, OH 43130 USA
Phones 24-hour (716) 348-2036 Work: (740) 654-2112
Email jeff.gebhart@rrd.com

CHEMICAL INVENTORY INFORMATION.

Mixture or Product Name: ADHESIVE

CAS #

- EHS Yes No
 Pure Mixture
 Solid Liquid Gas
 Identical to previous year
 Trade secret

PHYSICAL HAZARDS

- Explosive
 Flammable (gases, aerosols, liquids, or solids)
 Oxidizer (liquid, solid, or gas)
 Self-reactive
 Pyrophoric (liquid or solid)
 Pyrophoric gas
 Self-heating
 Organic peroxide
 Corrosive to metal
 Gas under pressure (compressed gas)
 In contact with water emits flammable gas
 Combustible dust

HEALTH HAZARDS:

- Acute toxicity (any route of exposure)
 Skin corrosion or irritation
 Serious eye damage or eye irritation
 Respiratory or skin sensitization
 Germ cell mutagenicity
 Carcinogenicity
 Reproductive toxicity
 Specific target organ toxicity (single or repeated exposure)
 Aspiration hazard
 Simple asphyxiant

Hazard not otherwise classified

AMOUNTS

- Below Reporting Thresholds
Maximum Amount: 47515 pounds Maximum Amount code: 07 (25,000 - 49,999 pounds)
Average Daily Amount: 26080 pounds Average Daily Amount code: 07 (25,000 - 49,999 pounds)
Max amount in largest container: 500 pounds
Days on site: 365

STORAGE LOCATIONS:

Confidential Yes No

Container Type: Fiber drum Pressure: Ambient pressure Temperature: Ambient temperature
Amount: 5935 pounds Location Description: AT PRESS, THROUGHOUT PRESSROOM

Container Type: Plastic Pales Pressure: Ambient pressure Temperature: Ambient temperature
Amount: 1080 pounds Location Description: AT PRESS, THROUGHOUT PRESSROOM

Container Type: Fiber drum Pressure: Ambient pressure Temperature: Ambient temperature

Facility: The Cyril-Scott Company (continued)

Amount: 40500 pounds Location Description INK ROOM - ROOM #3

MIXTURE COMPONENTS

Name POLYVINYL ACETATE RESINS CAS # 108-05-4 EHS
Max Amt Code 02 (100 - 499 pounds) Component Percentage 1 (by weight)

Name WATER CAS # 7732-18-5 EHS
Max Amt Code 06 (10,000 - 24,999 pounds) Component Percentage 50 (by weight)

STATE-SPECIFIC CHEMICAL DATA FIELDS FOR OH

Fee classification for this reported substance Hazardous Chemical

Mixture or Product Name: HEATSET OFFSET INK
CAS #

- EHS: Yes No
- Pure Mixture
- Solid Liquid Gas
- Identical to previous year
- Trade secret

PHYSICAL HAZARDS

- Explosive
- Flammable (gases, aerosols, liquids, or solids)
- Oxidizer (liquid, solid, or gas)
- Self-reactive
- Pyrophoric (liquid or solid)
- Pyrophoric gas
- Self-heating
- Organic peroxide
- Corrosive to metal
- Gas under pressure (compressed gas)
- In contact with water emits flammable gas
- Combustible dust

HEALTH HAZARDS

- Acute toxicity (any route of exposure)
- Skin corrosion or irritation
- Serious eye damage or eye irritation
- Respiratory or skin sensitization
- Germ cell mutagenicity
- Carcinogenicity
- Reproductive toxicity
- Specific target organ toxicity (single or repeated exposure)
- Aspiration hazard
- Simple asphyxiant

Hazard not otherwise classified

AMOUNTS

- Below Reporting Thresholds
- Maximum Amount: 35780 pounds Maximum Amount code 07 (25,000 - 49,999 pounds)
- Average Daily Amount: 29100 pounds Average Daily Amount code 07 (25,000 - 49,999 pounds)
- Max amount in largest container: 2750 pounds
- Days on site: 365

STORAGE LOCATIONS:

Confidential: Yes No

Container Type: Steel pipe Pressure: Greater than ambient pressure Temperature: Ambient temperature
Amount: 5080 pounds Location Description: In automatic ink pumping system in ceiling piping

Container Type: Plastic Pail Pressure: Ambient pressure Temperature: Ambient temperature

Tier Two
Emergency and Hazardous Chemical Inventory
Specific Information by Chemical

Reporting Period January 1 to December 31, 2019
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Printed February 19, 2020

Facility: The Cyril-Scott Company (continued)

Amount: 1000 pounds Location Description: Ink Room - Room 3

Container Type: Tote bin Pressure: Greater than ambient pressure Temperature: Ambient temperature
Amount: 8100 pounds Location Description: Located in the K018 Hantscho 2 Room and Room 11

Container Type: Tote bin Pressure: Greater than ambient pressure Temperature: Ambient temperature
Amount: 2700 pounds Location Description: Shipping Room 7

Container Type: Tote bin Pressure: Ambient pressure Temperature: Ambient temperature
Amount: 18900 pounds Location Description: Shipping Room 7

MIXTURE COMPONENTS

Name: 2,2,4 Trimethyl-1,3 pentanediol diisobutyrate CAS # 6846-50-0 [] EHS
Max Amt Code: 03 (500 - 999 pounds) Component Percentage: 1.5 (by weight)

Name: Calcium Resinate CAS # 9007-13-0 [] EHS
Max Amt Code: 04 (1,000 - 4,999 pounds) Component Percentage: 5 (by weight)

Name: Distillates (petroleum) solvent-refined heavy naphthenic CAS # 64741-96-4 [] EHS
Max Amt Code: 03 (500 - 999 pounds) Component Percentage: 1.5 (by weight)

Name: Hydrotreated light distillate CAS # 64742-47-8 [] EHS
Max Amt Code: 04 (1,000 - 4,999 pounds) Component Percentage: 4.43 (by weight)

Name: Kerosene (petroleum), Hydrodesulphurized CAS # 64742-81-0 [] EHS
Max Amt Code: 06 (10,000 - 24,999 pounds) Component Percentage: 30 (by weight)

Name: Straight-Run Middle Distillate (Petroleum) CAS # 64742-46-7 [] EHS
Max Amt Code: 04 (1,000 - 4,999 pounds) Component Percentage: 10 (by weight)

STATE-SPECIFIC CHEMICAL DATA FIELDS FOR OH

Fee classification for this reported substance: Hazardous Chemical

Mixture or Product Name: LUBE OILS

CAS #:

- EHS [] Yes [X] No
[] Pure [X] Mixture
[] Solid [X] Liquid [] Gas
[X] Identical to previous year
[] Trade secret

PHYSICAL HAZARDS:

- [] Explosive
[X] Flammable (gases, aerosols, liquids, or solids)
[] Oxidizer (liquid, solid, or gas)
[] Self-reactive
[] Pyrophoric (liquid or solid)
[] Pyrophoric gas
[] Self-heating

HEALTH HAZARDS:

- [] Acute toxicity (any route of exposure)
[X] Skin corrosion or irritation
[X] Serious eye damage or eye irritation
[X] Respiratory or skin sensitization
[] Germ cell mutagenicity
[] Carcinogenicity
[] Reproductive toxicity

Facility: The Cyril-Scott Company (continued)

- Organic peroxide
- Corrosive to metal
- Gas under pressure (compressed gas)
- In contact with water emits flammable gas
- Combustible dust
- Specific target organ toxicity (single or repeated exposure)
- Aspiration hazard
- Simple asphyxiant
- Hazard not otherwise classified

AMOUNTS:

- Below Reporting Thresholds
- Maximum Amount: 13883 pounds Maximum Amount code: 06 (10,000 - 24,999 pounds)
- Average Daily Amount: 10098 pounds Average Daily Amount code: 06 (10,000 - 24,999 pounds)
- Max amount in largest container: 458 pounds
- Days on site: 365

STORAGE LOCATIONS:

Confidential: Yes No

Container Type: Steel drum Pressure: Ambient pressure Temperature: Ambient temperature
Amount: 3785 pounds Location Description: Behind The Print Units throughout the Pressroom

Container Type: Steel drum Pressure: Ambient pressure Temperature: Ambient temperature
Amount: 5505 pounds Location Description: In compactor room #Room #9

Container Type: Steel drum Pressure: Ambient pressure Temperature: Ambient temperature
Amount: 10098 pounds Location Description: Oil Storage Area in Hunter Room #11

STATE-SPECIFIC CHEMICAL DATA FIELDS FOR OH

Fee classification for this reported substance: Hazardous Chemical

Mixture or Product Name: SULPHURIC ACID

CAS # 7664-93-9

- EHS: Yes No
- Pure Mixture
- Solid Liquid Gas
- Identical to previous year
- Trade secret

PHYSICAL HAZARDS:

- Explosive
- Flammable (gases, aerosols, liquids, or solids)
- Oxidizer (liquid, solid, or gas)
- Self-reactive
- Pyrophoric (liquid or solid)
- Pyrophoric gas
- Self-heating
- Organic peroxide
- Corrosive to metal
- Gas under pressure (compressed gas)
- In contact with water emits flammable gas
- Combustible dust

HEALTH HAZARDS:

- Acute toxicity (any route of exposure)
- Skin corrosion or irritation
- Serious eye damage or eye irritation
- Respiratory or skin sensitization
- Germ cell mutagenicity
- Carcinogenicity
- Reproductive toxicity
- Specific target organ toxicity (single or repeated exposure)
- Aspiration hazard
- Simple asphyxiant

2019 TIER II

Tier Two
Emergency and Hazardous Chemical Inventory
Specific Information by Chemical

Reporting Period January 1 to December 31, 2019
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Facility: The Cyril-Scott Company (continued)

Hazard not otherwise classified

AMOUNTS

Below Reporting Thresholds

Maximum Amount 3002 pounds Maximum Amount code 04 (1,000 - 4,999 pounds)

Average Daily Amount 2052 pounds Average Daily Amount code 04 (1,000 - 4,999 pounds)

Max amount in largest container 490 pounds

Days on site 365

STORAGE LOCATIONS

Confidential Yes No

Container Type Battery Pressure Ambient pressure Temperature Ambient temperature

Amount 50 pounds Location Description In backup power supplies in fire alarm monitoring panels, servers room, and data processing area

Container Type Battery Pressure Ambient pressure Temperature Ambient temperature

Amount 2052 pounds Location Description In batteries throughout the plant in PIV's, Golf Carts, Floor Scrubber, Fire Monitoring Panels, Power Backups in Server Room, data programming Room, and charging station in Room #2

MIXTURE COMPONENTS

Name SULPHURIC ACID CAS # 7664-93-9 EHS

Max Amt Code 04 (1,000 - 4,999 pounds) Component Percentage 100 (by weight)

STATE-SPECIFIC CHEMICAL DATA FIELDS FOR OH

Fee classification for this reported substance Extremely Hazardous Substance (EHS)

State/local fees \$360.00

I have attached a site plan

I have attached a list of site coordinate abbreviations

I have attached a description of dikes and other safeguard measures

Certification (Read and sign after completing all sections)

I certify under penalty of law that I have personally examined and am familiar with the information in pages 1 through 6 and that based on my inquiry of those individuals responsible for obtaining this information, I believe that the submitted information is true, accurate, and complete


Signature

02/19/2020


Date signed

Paul (Chip) Friesner

Name and official title of owner/operator

OR owner/operator's authorized representative

SNOKE HILL ROAD

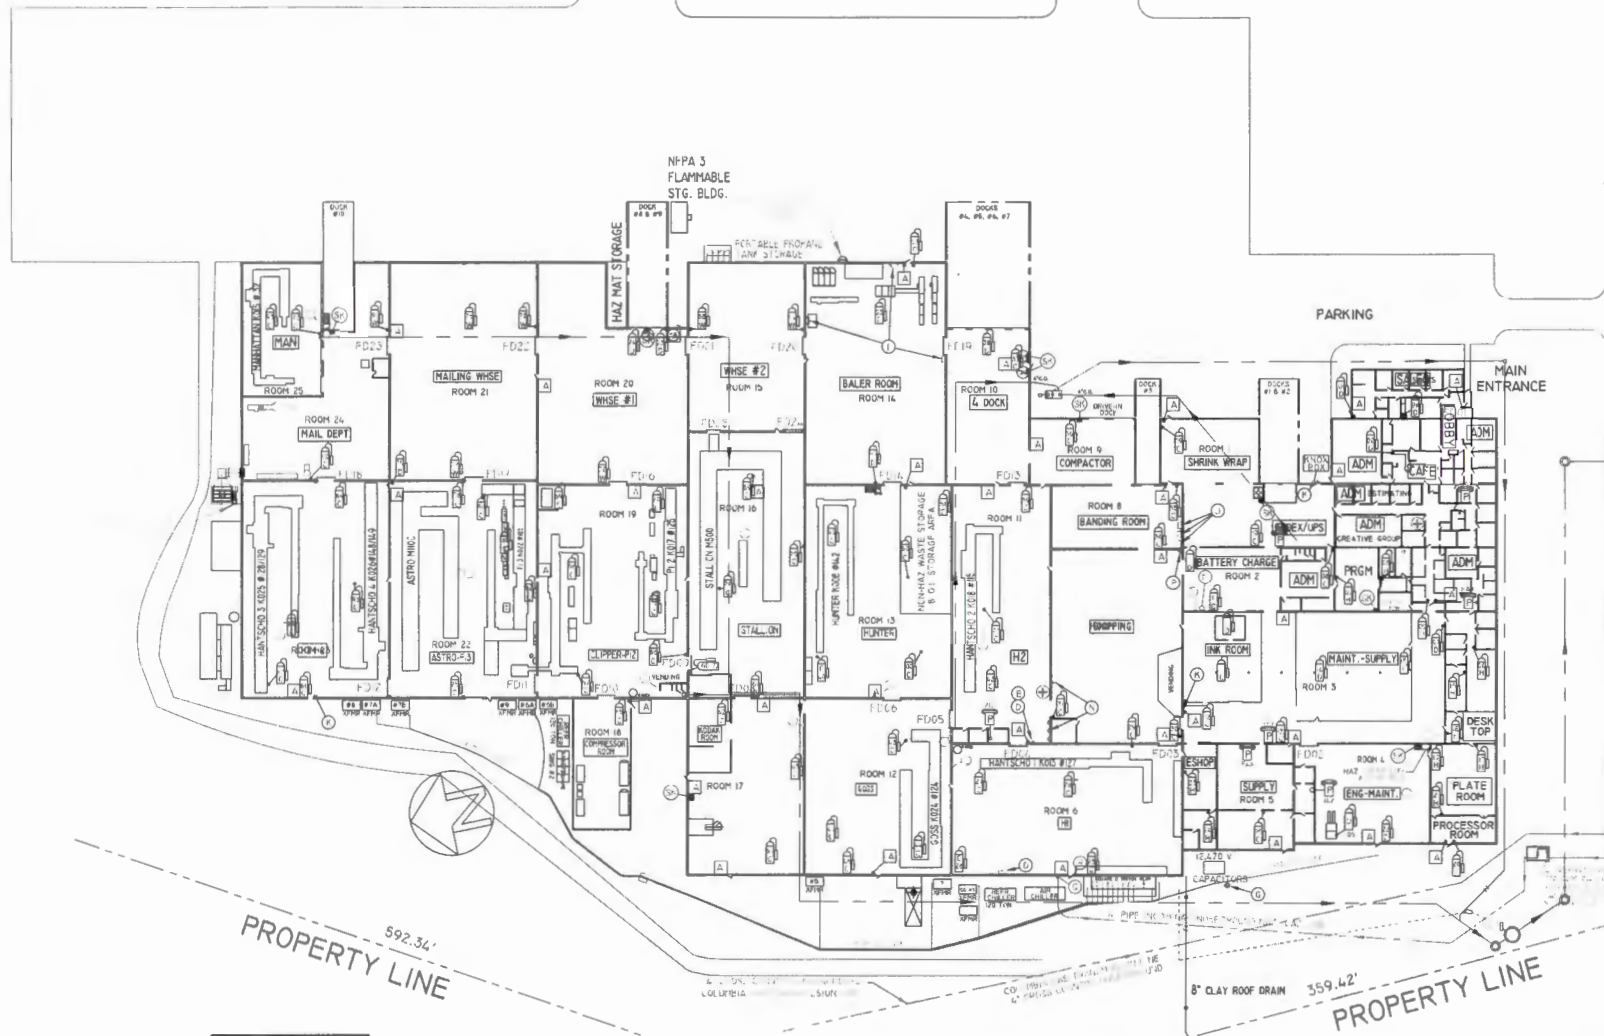


SAFETY LEGEND

D FRONT CHILL CONTROLS	N INN PUMP AIR VALVES	FIRE EXTINGUISHER - CARBON DIOXIDE	PIPE ALARM
E BACK CHILL CONTROLS	MAIN GAS VALVE HANDLE	FIRE EXTINGUISHER - HALON	SPILL KIT/HAZMAT SATELITE-PROTECTIVE GEAR
F SUBSTATION	AIR AS VALVE HANDLE	FIRE EXTINGUISHER - DRY CHEMICAL	EMERGENCY TELEPHONE (4) HANDSETS
G MAIN-BUSES POWER TO PLANT)		FIRE EXTINGUISHER - WATER	(3) FAX, (1) INST. JURY FAX AND PLUG IN PHONE)
I SAILER & CENTRAL VAC CONTROLS			
J COMPRESSOR CONTROLS - (3) UNITS			
K FIRE ALARM SYSTEM			

CYRIL-SCOTT			
FILE # 99ENL22-2		TITLE EMERGENCY EQUIPMENT LAYOUT	
DRAWN BY C.F.		DATE 12-8-02	
SCALE 1/32"=1'		DATE FEB 20, 2015	
MATERIAL		DRAWING NO. 99EN-134-L (1 OF 2)	

NOTE: ALL REGULAR PHONES HAVE 30-60 MIN. BATTERY COVER BACKUP IN CASE OF POWER FAILURE

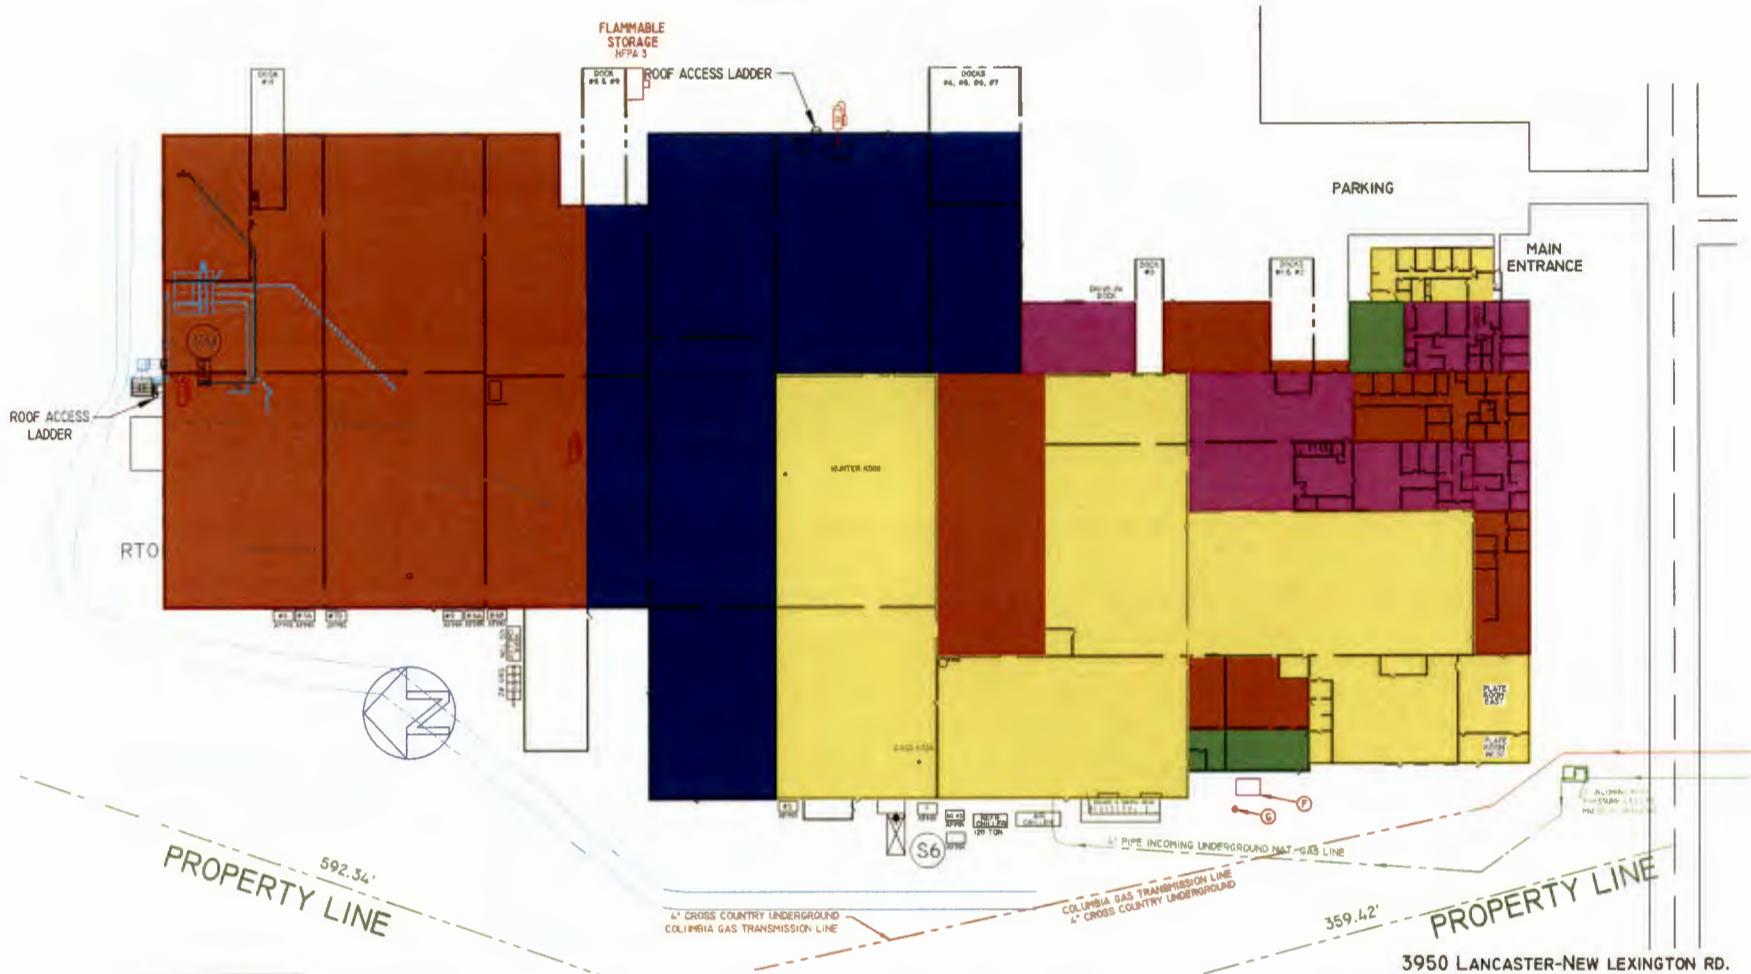

SAFETY LEGEND

- | | | |
|-----------------------------------|--------------------------------|----------------------------------|
| D FRONT CHILL CONTROLS | I EMERGENCY SHOWER | FIRE EXTINGUISHER - DRY CHEMICAL |
| E BACK CHILL CONTROLS | M EMERGENCY SHOWER | |
| F SUBSTATION | N INK PUMP AIR VALVES | |
| G MAIN FUSES (POWER TO PLANT) | Q MAIN GAS SHUTOFF VALVE | |
| I BAILER & CENTRAL VAC CONTROLS | R MAIN GAS SHUTOFF VALVE RISER | |
| J COMPRESSOR CONTROLS - (3) UNITS | | |


ROOF TOP

3950 LANCASTER-NEW LEXINGTON RD.
LANCASTER, OHIO 43130

CYRIL-SCOTT

FILE: 9GEN-134-2 PLANT LAYOUT DRAWING NO.: 9GEN-134-4 DATE: 02.20.15		TITLE: EMERGENCY EQUIPMENT ROOF LAYOUT	
DRAWN BY: C.F. DATE: 10.09.08 SCALE: 1/32"=1' 1/32"=1'	QUANTITY NEEDED: 02.20.15	DRAWING NO: 9GEN-134-4 (2 OF 2)	

REV.	DATE	BY	REVISION
1	11/07	WKP	ISSUE FOR A LIGHT PLAN
2	11/07	WKP	REVISED TO ADD DOOR #10

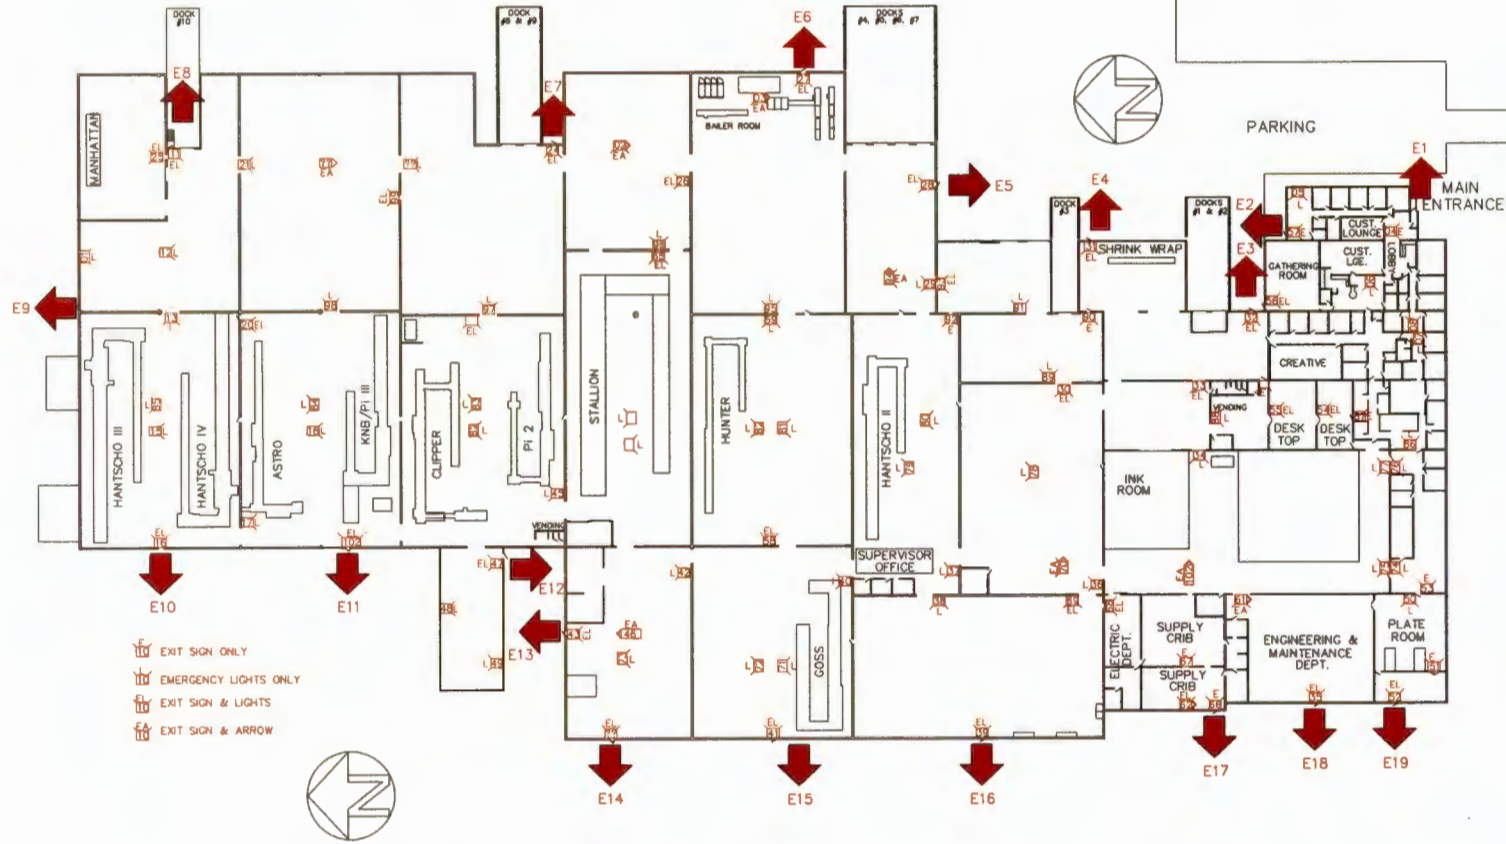


- EXIT SIGN ONLY
- EMERGENCY LIGHTS ONLY
- EXIT SIGN & LIGHTS
- EXIT SIGN & ARROW

EMERGENCY EXITS & LIGHTS

The Cyril-Scott Company
 3950 Lancaster-New Lexington Road
 Lancaster, Ohio 43130

CYRIL-SCOTT			
EMERGENCY EXITS & LIGHTS			
DATE: 8/07	SCALE: 1/32" = 1'		
PROJECT: ()			
DRAWN BY: 9GEN-161-4			CHECKED BY: 3

- Tank 1 = 90 Regular Gasoline
- Tank 2 = On Road Diesel
- Tank 3 = 89 E Gasoline
- Tank 4 = Off Road Diesel
- Tank 5 = Additive
- Tank 6 = 87 E Gasoline
- Tank 8 = Off Road Diesel
- Tank 9 = On Road Diesel

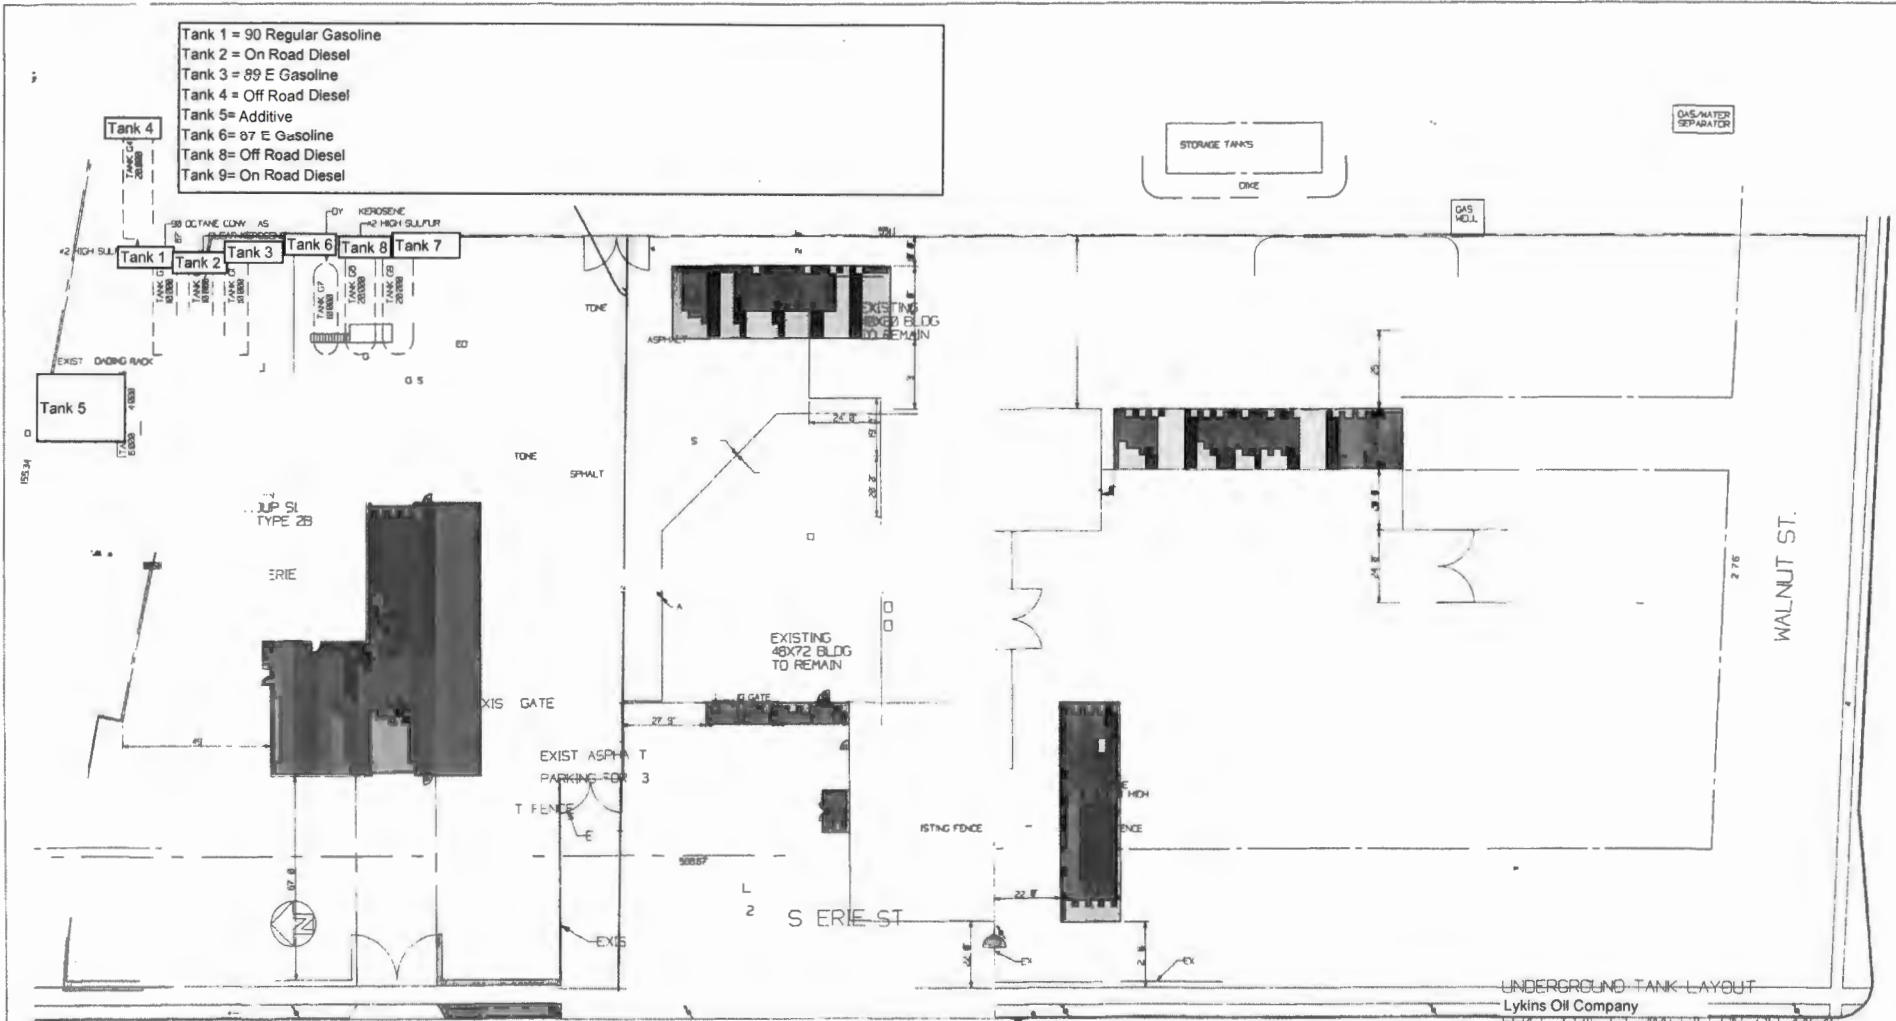

UNDERGROUND TANK LAYOUT
 Lykins Oil Company
 650 S. ERIE ST., MASSILLON, OH 44646
 SCALE 1" = 40' DATE 02/18/15